



# PhilGEPS

Philippine Government Electronic Procurement System

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Philippine Government  
Procurement Opportunities

## Bid Notice Abstract

### Request for Quotation (RFQ)

**Reference Number** 10583561  
**Procuring Entity** CARLOS HILADO MEMORIAL STATE UNIVERSITY  
**Title** Procurement of Labor and Materials for the Rehabilitation of Drainage in Front of Bus Garage - Talisay Campus  
**Area of Delivery** Negros Occidental

<b>Solicitation Number:</b> RFQ 24-034 <b>Trade Agreement:</b> Implementing Rules and Regulations <b>Procurement Mode:</b> Negotiated Procurement - Small Value Procurement (Sec. 53.9) <b>Classification:</b> Civil Works <b>Category:</b> Construction Projects <b>Approved Budget for the Contract:</b> PHP 540,000.00 <b>Delivery Period:</b> 45 Day/s <b>Client Agency:</b>  <b>Contact Person:</b> Rowena De la Vida Prado Administrative Assistant II Mabini Street Talisay City Negros Occidental Philippines 6115 63-34-7120005 Ext.142 63-939-9296624 bac.sec@chmsu.edu.ph	<b>Status</b>	<b>Pending</b>
	<b>Associated Components</b>	1
	<b>Bid Supplements</b>	0
	<b>Document Request List</b>	0
	<b>Date Published</b>	22/02/2024
	<b>Last Updated / Time</b>	21/02/2024 16:36 PM
	<b>Closing Date / Time</b>	27/02/2024 09:00 AM

**Description**

Republic of the Philippines  
 CARLOS HILADO MEMORIAL STATE UNIVERSITY  
 Talisay City, Negros Occidental  
 Mobile Phone Number: 0939 929 6624  
 bac.sec@chmsc.edu.ph

REQUEST FOR QUOTATION  
 Page 1 of 5  
 Date: FEBRUARY 21, 2024  
 Quotation No. 24-034

Please quote your lowest price on the item/s listed below, stating the shortest time of delivery and submit your quotation duly signed by your representative not later than \_\_\_\_\_ in the return envelope attached herewith.

DR. ANDREW EUSEBIO S.TAN  
 BAC Chairman

**NOTE:**

- ALL ENTRIES MUST BE TYPEWRITTEN
- DELIVERY PERIOD WITHIN 45 CALENDAR DAYS
- WARRANTY SHALL BE FOR A PERIOD OF SIX (6) MONTHS FOR SUPPLIES & MATERIALS, ONE (1) YEAR FOR EQUIPMENT, FROM DATE OF ACCEPTANCE BY THE PROCURING ENTITY
- PRICE VALIDITY SHALL BE FOR A PERIOD OF \_\_\_\_\_ CALENDAR DAYS
- G-EPS REGISTRATION CERTIFICATE SHALL BE ATTACHED UPON SUBMISSION OF THE QUOTATION

6. BIDDERS SHALL SUBMIT ORIGINAL BROCHURES SHOWING CERTIFICATIONS OF THE PRODUCT BEING OFFERED

ITEM DESCRIPTION OF WORKS QTY. UNIT MATERIAL COST LABOR COST TOTAL COST  
 NO. Unit Cost Material Sub-Total Cost Unit Cost Labor Sub-Total Cost

ONE (1) LOT  
 LABOR AND MATERIALS FOR THE REHABILITATION OF DRAINAGE IN FRONT OF BUS GARAGE - TALISAY CAMPUS

Scope of Works:

1.0 GENERAL REQUIREMENTS

- 1.1 Mobilization and Demobilization
- 1.2 Safety Occupational Hazards
- 1.3 Site Clearing, Cleaning & Hauling
- 1.4 Excavation works and Back filling (including demolition of old drainage)
- 1.5 Spreading, Scraping and Compaction of sub grade materials
- 1.6 Equipment Rentals

2.0 STRUCTURAL WORKS

- 2.1 Road shoulder ( Concrete premix 4,000 psi)
- 2.2 Concrete sidewalk slab and ramp (Concrete pre mix 4,000 psi)
- 2.3 Concrete drainage cover and catch basin (Concrete premix 4,000 psi)
- 2.4 Installation of reinforced bars and dowels (Road shoulder, side walk slab, catch basin and drainage cover)
- 2.5 Installation of reinforced concrete pipe drainage line
- 2.6 Fabrication and installation of drainage gratings

3.0 ARCHITECTURAL WORKS

- 3.1 Road sidewalk markings
- 3.2 Painting of steel gratings (zinc chromate)
- 3.3 Installation of formworks

4.0 MISCELLANEOUS WORKS

BILL OF QUANTITIES

1.0 GENERAL REQUIREMENTS

- 1.1 Mobilization and Demobilization 1.00 lot
- 1.2 Safety Occupational Hazards 1.00 lot
- 1.3 Site Clearing, Cleaning & Hauling 1.00 lot
- 1.4 Excavation works and filling (including demolition of old drainage) 1.00 lot
- 1.5 Spreading, Scraping and Compaction of sub grade materials 1.00 lot
- 1.6 Equipment Rentals 1.00 lot

Sub-total, 1.0 (GENERAL REQUIREMENTS)

2.0 STRUCTURAL WORKS

- 2.1 Ready mix concrete 4,000 psi 16.00 cu.m
- 2.2 12mm Ø DSB 60.00 lengths
- 2.3 10mm Ø DSB 68.00 lengths
- 2.4 Concrete bonding agent (structural) 1.00 lot
- 2.5 Portland Cement (40kgs) Premium 10.00 bags
- 2.6 Aggregate base course 14.00 cu.m
- 2.7 0.60mØ x 1.00m Reinforce Concrete Pipe 25.00 pcs
- 2.8 Filling materials 8.00 cu.m
- 2.9 Steel Grittings 1.00 lot
- 2.10 Drainage cover handle 1.00 lot
- 2.11 #16 G.I Wire 10.00 kilos

Sub-total, 2.0 (STRUCTURAL WORKS)

3.0 ARCHITECTURAL WORKS

- 3.1 Pavements and gutter markings (paint) 1.00 lot
- 3.2 Zinc Chromate paint 3.00 gal
- 3.3 Paint Thinner 2.00 gal
- 3.4 Formworks 1.00 lot

Sub-total, 3.0 (ARCHITECTURAL WORKS)

4.0 MISCELLANEOUS WORKS

- 4.1 FOR ALL OTHER ITEMS that are not included on listed Bill of Quantities in your Bid but are deemed necessary for the completion of the works and the delivery of the project. 1.00 lot

Sub-total, 4.0 (MISCELLANEOUS WORKS)

PROJECT DURATION: 45 CALENDAR DAYS  
 Note: Attach Certificate of Site Inspection

- A. TOTAL DIRECT COST
- B. CONSUMABLES:
- C. SUPERVISION AND ADMINISTRATION:
- D. TOTAL INDIRECT COST (B+C):
- E. TOTAL COST (A+D)
- F. VAT (12% OF ITEM E):
- GRAND TOTAL OF PROJECT COST:

\*\*\*\*\*NOTHING FOLLOWS\*\*\*\*\*

TOTAL ABC = Php 540,000.00

PROCUREMENT OF LABOR AND MATERIALS FOR THE REHABILITATION OF DRAINAGE IN FRONT OF BUS GARAGE -  
TALISAY CAMPUS/J. MARQUEZ  
PR# 24-056-0202 02-02-24  
MDS 38-101-24-02 02-13-24

**Line Items**

Item No.	Product/Service Name	Description	Quantity	UOM	Budget (PHP)
1	ONE (1) LOT	Labor and Materials for the Rehabilitation of Drainage in Front of Bus Garage	1	Lot	540,000.00

**Created by** Rowena De la Vida Prado

**Date Created** 21/02/2024

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## REQUEST FOR QUOTATION

Page 1 of 5

Date: FEBRUARY 21, 2024  
 Quotation No. 24-034

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**DR. ANDREW EUSEBIO S.TAN**  
 BAC Chairman

**NOTE:**

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4. PRICE VALIDITY SHALL BE FOR A PERIOD OF \_\_\_\_\_ CALENDAR DAYS
5. G-EPS REGISTRATION CERTIFICATE SHALL BE ATTACHED UPON SUBMISSION OF THE QUOTATION
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ITEM NO.	DESCRIPTION OF WORKS	QTY.	UNIT	MATERIAL COST		LABOR COST		TOTAL COST
				Unit Cost	Material Sub-Total Cost	Unit Cost	Labor Sub-Total Cost	
	<b>ONE (1) LOT</b>							
	<b>LABOR AND MATERIALS FOR THE REHABILITATION OF DRAINAGE IN FRONT OF BUS GARAGE - TALISAY CAMPUS</b>							
	<b>Scope of Works:</b>							
<b>1.0</b>	<b>GENERAL REQUIREMENTS</b>							
1.1	Mobilization and Demobilization							
1.2	Safety Occupational Hazards							
1.3	Site Clearing, Cleaning & Hauling							
1.4	Excavation works and Back filling (including demolition of old drainage)							
1.5	Spreading, Scraping and Compaction of sub grade materials							
1.6	Equipment Rentals							
<b>2.0</b>	<b>STRUCTURAL WORKS</b>							
2.1	Road shoulder ( Concrete premix 4,000 psi)							
2.2	Concrete sidewalk slab and ramp (Concrete pre mix 4,000 psi)							
2.3	Concrete drainage cover and catch basin (Concrete premix 4,000 psi)							

Released (BAC) \_\_\_\_\_ Date \_\_\_\_\_ By \_\_\_\_\_  
 Returned (Supplier) \_\_\_\_\_

\_\_\_\_\_  
 Printed Name/Signature

\_\_\_\_\_  
 Tel. No./Cellphone No.

\_\_\_\_\_  
 Date





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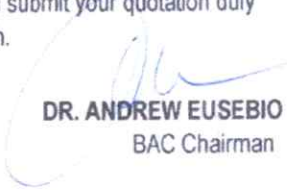
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ITEM NO.	DESCRIPTION OF WORKS	QTY.	UNIT	MATERIAL COST		LABOR COST		TOTAL COST
				Unit Cost	Material Sub-Total Cost	Unit Cost	Labor Sub-Total Cost	
2.4	Installation of reinforced bars and dowels (Road shoulder, side walk slab, catch basin and drainage cover)							
2.5	Installation of reinforced concrete pipe drainage line							
2.6	Fabrication and installation of drainage gratings							
<b>3.0</b>	<b>ARCHITECTURAL WORKS</b>							
3.1	Road sidewalk markings							
3.2	Painting of steel gratings (zinc chromate)							
3.3	Installation of formworks							
<b>4.0</b>	<b>MISCELLANEOUS WORKS</b>							
<b>BILL OF QUANTITIES</b>								
<b>1.0</b>	<b>GENERAL REQUIREMENTS</b>							
1.1	Mobilization and Demobilization	1.00	lot					
1.2	Safety Occupational Hazards	1.00	lot					
1.3	Site Clearing, Cleaning & Hauling	1.00	lot					
1.4	Excavation works and filling (including demolition of old drainage)	1.00	lot					
1.5	Spreading, Scraping and Compaction of sub grade materials	1.00	lot					

Date

By

Released (BAC) \_\_\_\_\_  
 Returned (Supplier) \_\_\_\_\_

Printed Name/Signature

Tel. No./Cellphone No.

Date



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				Unit Cost	Material Sub-Total Cost	Unit Cost	Labor Sub-Total Cost	
1.6	Equipment Rentals	1.00	lot					
	<b>Sub-total, 1.0 (GENERAL REQUIREMENTS)</b>							
<b>2.0</b>	<b>STRUCTURAL WORKS</b>							
2.1	Ready mix concrete 4,000 psi	16.00	cu.m					
2.2	12mm Ø DSB	60.00	lengths					
2.3	10mm Ø DSB	68.00	lengths					
2.4	Concrete bonding agent (structural)	1.00	lot					
2.5	Portland Cement (40kgs) Premium	10.00	bags					
2.6	Aggregate base course	14.00	cu.m					
2.7	0.60mØ x 1.00m Reinforce Concrete Pipe	25.00	pcs					
2.8	Filling materials	8.00	cu.m					
2.9	Steel Grittings	1.00	lot					
2.10	Drainage cover handle	1.00	lot					
2.11	#16 G.I Wire	10.00	kilos					
	<b>Sub-total, 2.0 (STRUCTURAL WORKS)</b>							
<b>3.0</b>	<b>ARCHITECTURAL WORKS</b>							
3.1	Pavements and gutter markings (paint)	1.00	lot					

Date

By

Released (BAC) \_\_\_\_\_  
 Returned (Supplier) \_\_\_\_\_

Printed Name/Signature

Tel. No./Cellphone No.

Date





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				Unit Cost	Material Sub-Total Cost	Unit Cost	Labor Sub-Total Cost	
3.2	Zinc Chromate paint	3.00	gal					
3.3	Paint Thinner	2.00	gal					
3.4	Formworks	1.00	lot					
	<b>Sub-total, 3.0 (ARCHITECTURAL WORKS)</b>							
<b>4.0</b>	<b>MISCELLANEOUS WORKS</b>							
4.1	FOR ALL OTHER ITEMS that are not included on listed Bill of Quantities in your Bid but are deemed necessary for the completion of the works and the delivery of the project.	1.00	lot					
	<b>Sub-total, 4.0 (MISCELLANEOUS WORKS)</b>							
	PROJECT DURATION: 45 CALENDAR DAYS							
	Note: Attach Certificate of Site Inspection							
	<b>A. TOTAL DIRECT COST</b>							
	<b>B. CONSUMABLES:</b>							
	<b>C. SUPERVISION AND ADMINISTRATION:</b>							
	<b>D. TOTAL INDIRECT COST (B+C):</b>							

Released (BAC) \_\_\_\_\_ Date \_\_\_\_\_ By \_\_\_\_\_  
 Returned (Supplier) \_\_\_\_\_

\_\_\_\_\_  
 Printed Name/Signature  
 \_\_\_\_\_  
 Tel. No./Cellphone No.  
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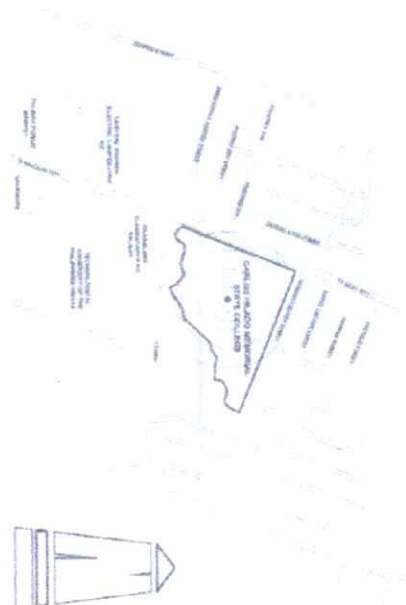
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				Unit Cost	Material Sub-Total Cost	Unit Cost	Labor Sub-Total Cost	
	<b>E. TOTAL COST (A+D)</b>							
	<b>F. VAT (12% OF ITEM E):</b>							
	<b>GRAND TOTAL OF PROJECT COST:</b>							
	<b>*****NOTHING FOLLOWS*****</b>							
	<b>TOTAL ABC = Php 540,000.00</b>							
	PROCUREMENT OF LABOR AND MATERIALS FOR THE REHABILITATION OF DRAINAGE IN FRONT OF BUS GARAGE - TALISAY CAMPUS/J. MARQUEZ							
	PR# 24-056-0202 02-02-24							
	MDS 38-101-24-02 02-13-24							


Released (BAC) \_\_\_\_\_ Date \_\_\_\_\_  
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\_\_\_\_\_  
 Printed Name/Signature  
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 Tel. No./Cellphone No.  
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 Date






VICINITY MAP  
SCALE NDTs



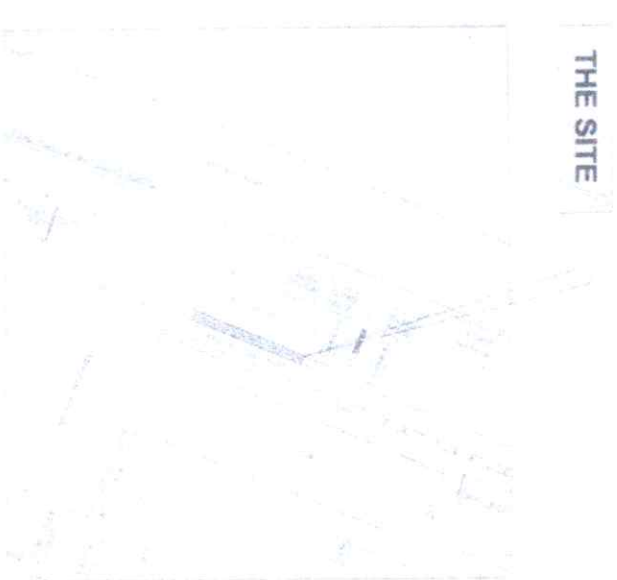



THE SITE  
SCALE




PERSPECTIVE DRAWING  
SCALE NDTs

 Republic of the Philippines <b>CALCUT RIZAL EDUCATIONAL STATE UNIVERSITY</b> Higher Education <small>OFFICE OF THE PRINCIPAL ARCHITECT</small>		<b>PROJECT TITLE:</b> REHABILITATION OF DRAINAGE IN FRONT OF BUB GARAGE <small>PROJECT LOCATION: CHASS MARH CAMPUS</small>	<b>PREPARED BY:</b> ANNELE R. LATIPNAS <small>REGISTERED DRAFTSMAN</small>	<b>CHECKED BY:</b> ENGR. GANI M. MANSURTO JR. <small>REGISTERED ARCHITECT</small>	<b>ENGINEER:</b> ENGR. JUN-JUN J. MANSURTO <small>DIRECTOR FROM</small>	<b>BOSSALINDA S. TUYILA, J.D.</b> <small>VIC. PRESIDENT FOR ADMINISTRATION AND FINANCE</small>	<b>APPROVED BY:</b> NORBERTO MANGUILLANAN, Ph.D. <small>SUP. PRESIDENT</small>	<b>SHEET NO.:</b> <b>A</b>	<b>PAGE NO.:</b> <b>1</b>
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
**LEGEND:**

-  CONCRETE SLAB REHABILITATION
-  RCP PIPE TO BE INSTALLED
-  OPEN CRAWL
-  MANHOLES

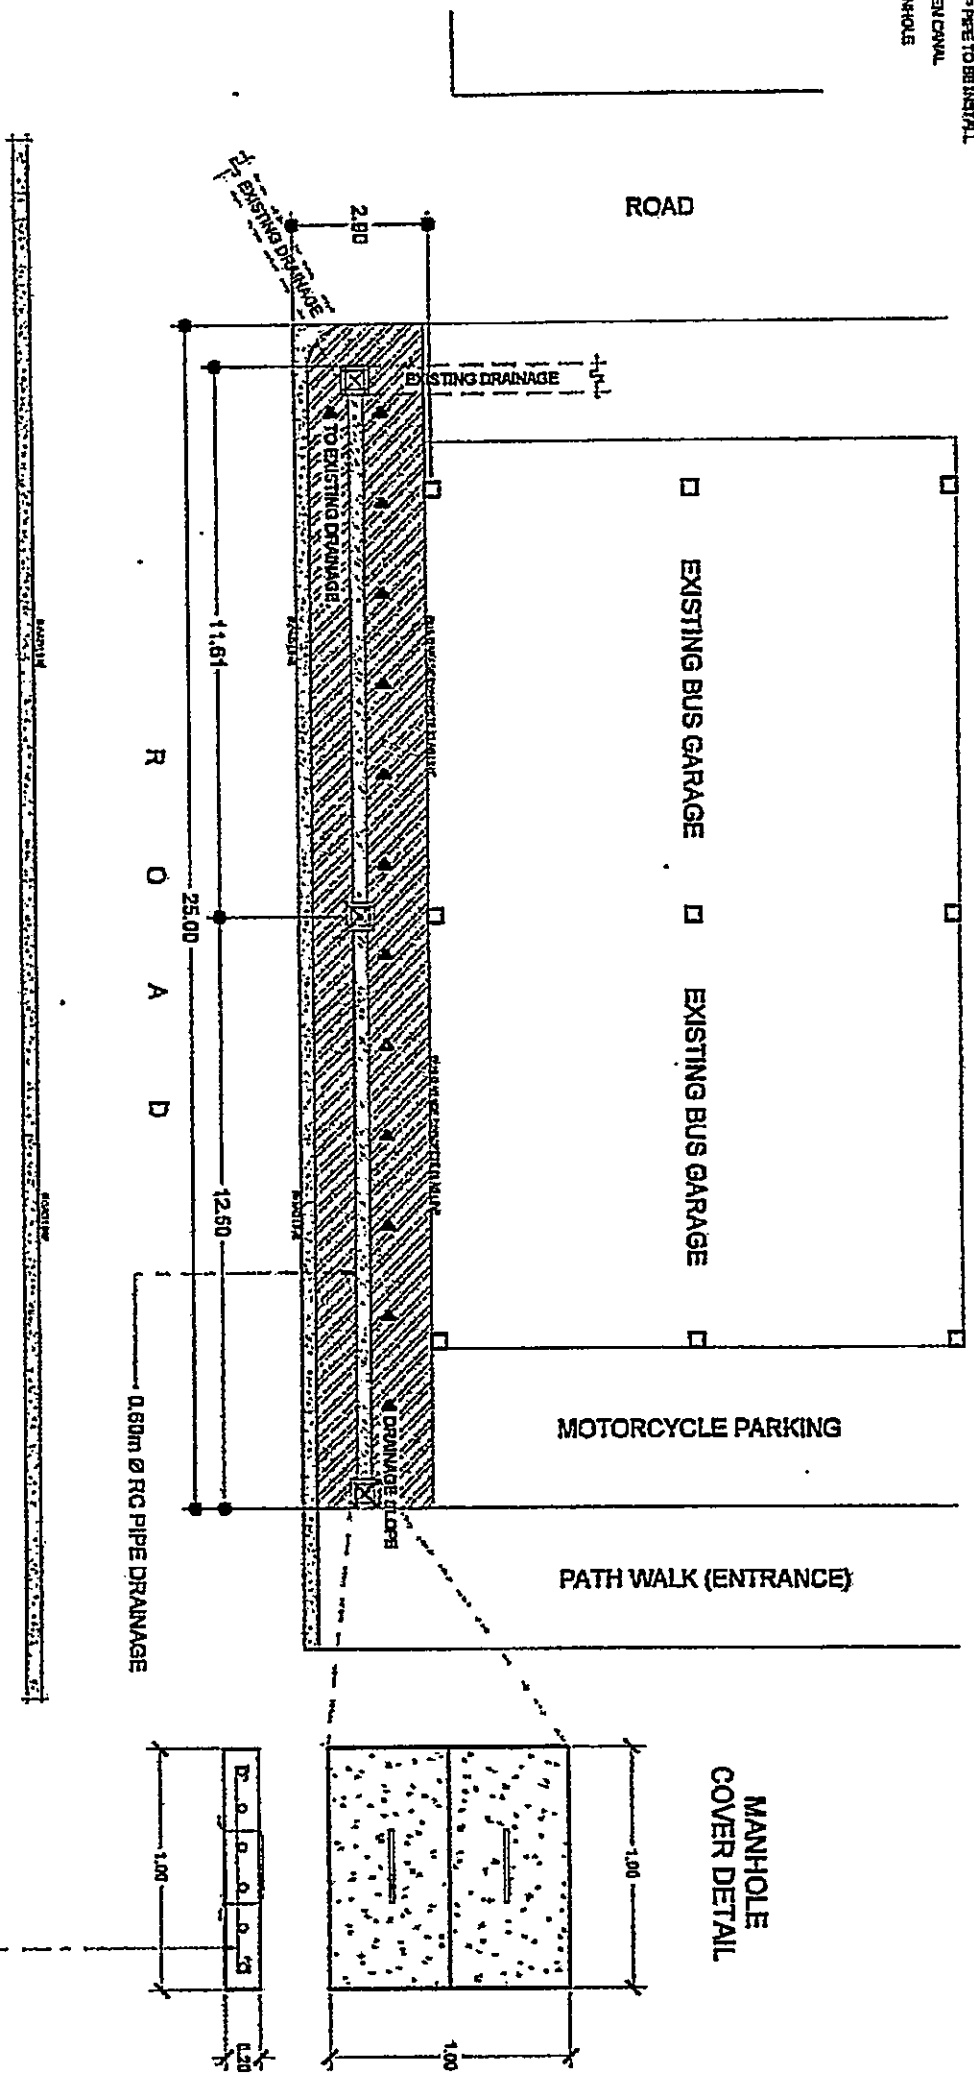

0.20m THICK CONCRETE SLAB WITH 10mm Ø MAT BARS SPACED @ 0.175m, O.C. BOTH WAYS DOUBLE MATTING (4,000 PSI)

**FLOOR PLAN**  
SCALE 1:1500

 Republic of the Philippines DEPARTMENT OF TRANSPORTATION Bureau of Road and Transport Engineering and Maintenance		<b>PROJECT TITLE</b> REHABILITATION OF DRAINAGE IN FRONT OF BUS GARAGE		<b>PREPARED BY:</b> ARNIEB LANTERAS UNIVERSITY OF THE PHILIPPINES		<b>CHECKED BY:</b> [Signature] ASST. CHIEF ENGINEER BUREAU OF ROAD AND TRANSPORT ENGINEERING AND MAINTENANCE		<b>APPROVED BY:</b> [Signature] ROSEMONDA S. TRIVIA, ID VICE PRESIDENT FOR ADMINISTRATION AND FINANCE		<b>ENGINEER IN CHARGE:</b> ROBERTO M. REGULARMAN, P.E. RCP PRESIDENT		<b>SHEET NO.:</b> A		<b>PAGE NO.:</b> 2	
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**LEGEND:**


-  CONSTRUCTION OF CONCRETE SLAB
-  EXISTING CONCRETE SLAB
-  RC PIPE TO BE INSTALLED
-  COMPACTED FILL

**DROP CANAL SECTION**



0.20M THICK CONCRETE SLAB WITH 10mm Ø MAT BARS SPACED @ 0.175M O.C. BOTH WAYS DOUBLE MATTING (4 000 PSI)

DROP CANAL (SEE DETAIL)

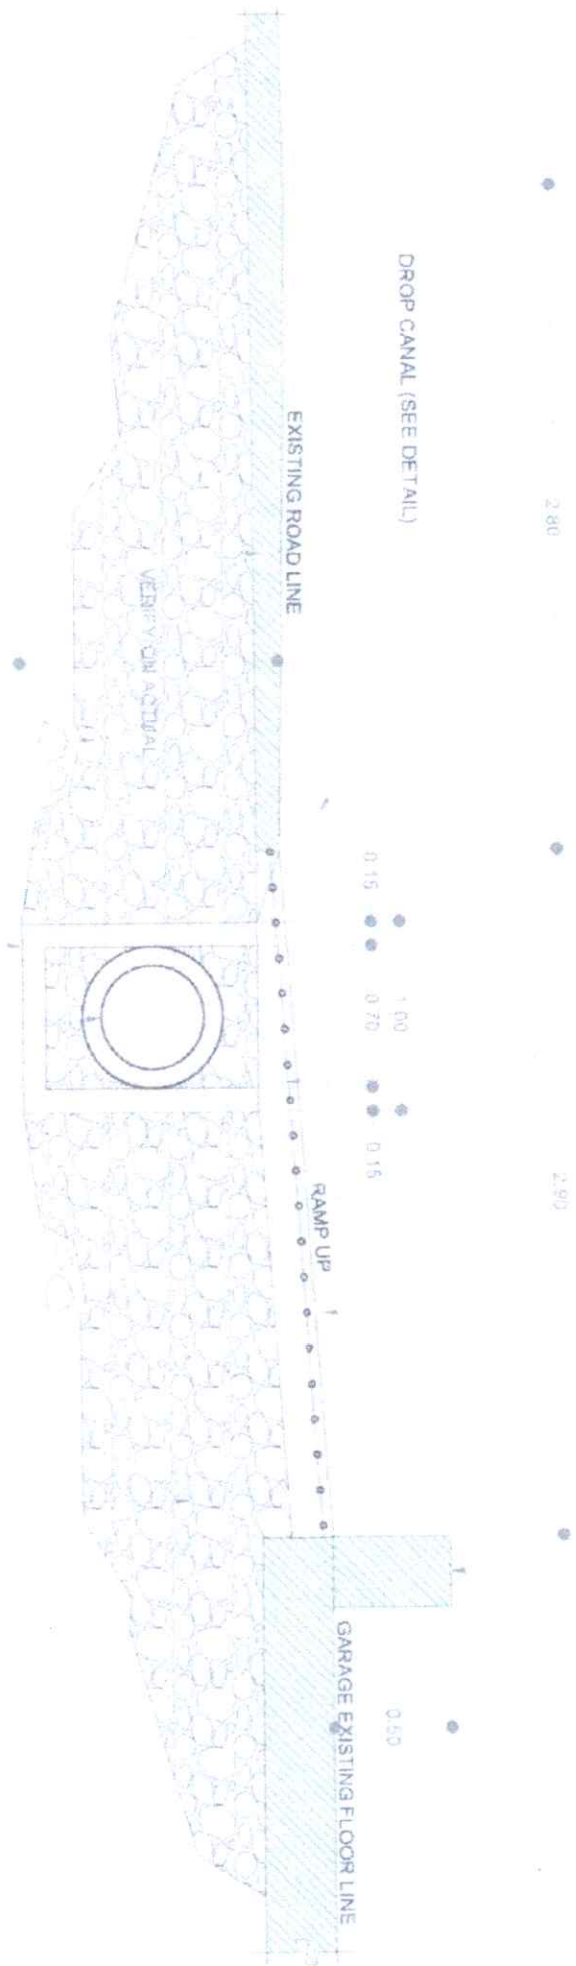

EXISTING ROAD  
COMPACTED FILL


CATCH BASIN (SEE DETAIL)

**DRAINAGE SECTION**

SCALE 1:30M


0.60M Ø RC PIPE DRAINAGE  
(DRAINAGE SLOPE & ELEVATION,  
VERIFY ON ACTUAL)

COMPACTED FILL


 DEPARTMENT OF PUBLIC WORKS AND HIGHWAYS OFFICE OF THE ASSISTANT SECRETARY FOR PLANNING AND DESIGN CIVIL ENGINEERING DIVISION	PROJECT TITLE	PREPARED BY	CHECKED BY	DIRECTOR PDM	VICE PRESIDENT FOR ADMINISTRATION AND FINANCE	APPROVED BY	SHEET NO.	PAGE NO.
	REHABILITATION OF DRAINAGE IN FRONT OF 805 GARAGE PROJECT LOCATION: CALSON CHANU MAIN CANALS	ARNEL R. LATURNAS UNIVERSITY ENGINEER	<i>[Signature]</i> INSR. GENERAL ENGINEER	<i>[Signature]</i> INSR. GENERAL ENGINEER	RIGORIO J. J. MAQUET DIRECTOR PDM	ROSALINDA S. IDYIA VICE PRESIDENT FOR ADMINISTRATION AND FINANCE	NORBERTO P. MANCILLANAN, Ph.D. SAC, PRESIDENT	A




TOP VIEW

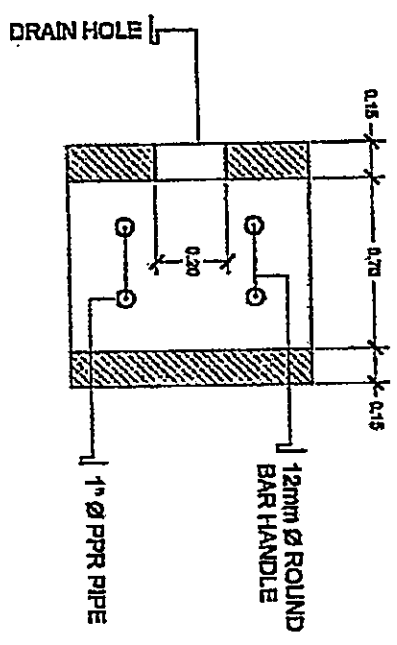

DRAINAGE COVER DETAIL

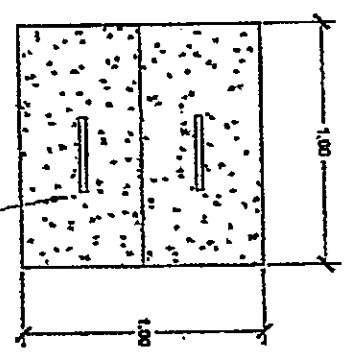


0.20m THICK CONCRETE SLAB WITH 10mm Ø MAT BARS SPACED @ 0.175M, O.C, BOTH WAYS DOUBLE MATTING (4,000 PSI)

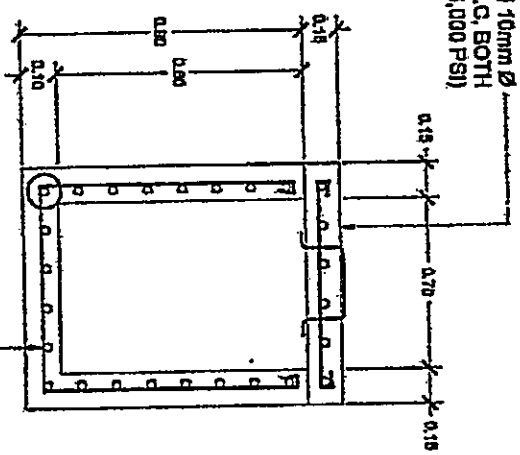

SECTION


10mm Ø MAT BARS SPACED @ 0.175M, O.C, BOTH WAYS DOUBLE MATTING (4,000 PSI)

1.00m x 1.00m DRAINAGE COVER

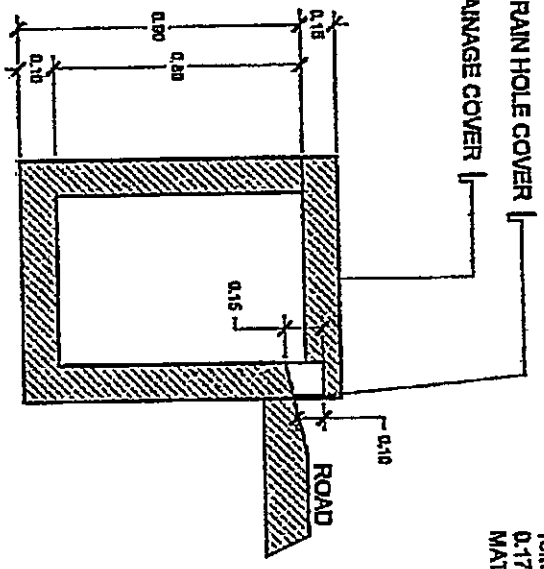

0.20m THICK CONCRETE SLAB WITH 10mm Ø MAT BARS SPACED @ 0.175M, O.C, BOTH WAYS DOUBLE MATTING (4,000 PSI)

TYPICAL DRAINAGE MANHOLE DETAIL  
SCALE: 1:300M

 <p>Republic of the Philippines BOARD OF CIVIL ENGINEERS 1001 BRUNNEN Manila, Philippines</p>	PROJECT TITLE:	PREPARED BY:	CHECKED BY:	DESIGNED BY:	APPROVED BY:	SHEET NO.:	PAGES:
	REPAIR/RECONSTRUCTION OF BRIDGE	ARNEL L. LANTONAS	AL. ALONSO	AL. ALONSO	ROSAURIDA S. TIVILAN	A	4
PROJECT LOCATION: CANTON BRIDGE	THIRD YEAR	DATE: 11/15/2010	DATE: 11/15/2010	DATE: 11/15/2010			